

Date Issued: 15 October 2021

NOTICE OF AN APPLICATION FOR A PLANNING PERMIT

The land affected by the application is located at: 42 McLeod Street, Kirwans

Bridge VIC 3608

The application is for a Permit for: Development of a Replacement

Dwelling

The applicant for the Permit is: CBA Building Designers

The application Reference Number is: P2021-178

You may view the application and any documents that support the application on our website at

https://www.strathbogie.vic.gov.au/development/statutory-planning/planning-permitscurrently-advertised

or at the office of the Responsible Authority during office hours:

Strathbogie Shire Council 109A Binney Street Euroa Telephone: (03) 5795 0000

Any person who may be affected by the granting of the Permit may object or make other submissions to the Responsible Authority.

An objection must be sent to the Responsible Authority in writing, include the reasons for the objection and state how the objector would be affected.

The Responsible Authority will not decide on the application before: 05 November 2021

All objections are placed on the relevant Planning Permit application file, which is publicly available at all times. Objections can therefore be read and used by other parties.


An objection form is available from Strathbogie Shire Council office, by phoning Council on (03) 5795 0000 or at https://www.strathbogie.vic.gov.au/development/statutory-planning/objections

If you submit an objection, the Responsible Authority will tell you of its final decision.

TOWN PLANNING ONLY

NOT TO BE USED FOR CONSTRUCTION

42 McLeod St, Kirwans Bridge 3608

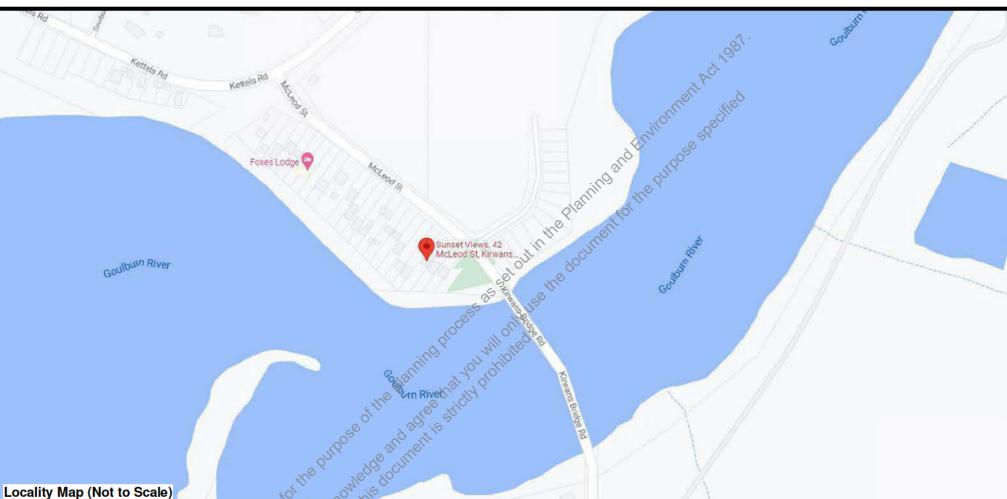

Project: 21-00 30/09/2021 1:25:04 PM



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	TP03	Proposed Site Plan
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Sheet Number	Sheet Name	Current Revision	Current Revision Date	Sheet Issue Date
TP00	Cover Sheet			30/09/2021
TP01	Existing/Demolition Plans			30/09/2021
TP02	Photographic Study			30/09/2021
TP03	Proposed Site Plan			30/09/2021
TP04	Proposed Floor Plan			30/09/2021
TP05	Proposed Elevations			30/09/2021
TP06	Proposed Elevations			30/09/2021
TP07	Facade Perspectives			30/09/2021
TP08	Perspectives			30/09/2021
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building designers

T: 5441 5545 W: cba.net.au E: admin@cba.net.au A: PO Box 895, Bendigo, VIC, 3552

TP00

All materials and work practices shall comply with, but not limited to, the building Interim Regulations 2017, the National Construction COde Series 2016 Building Code of Australia Vol 2 and all relevant current Australian standards (as amended) referred to therein. These specifications specify only the minium standard of work for the demolition works on residential projects, and all workmanship and precautions shall be to best trade practice.

Precautions must be taken before and during demolition in accordance with AS 2601-2001: The Demolition of Structures.

During the progress of the demolition, the works shall be under the continuous supervision of the Demolisher or of an experienced foreman, and demolition shall be executed storey by storey commencing at the roof and working downwards.

The demolition must not be commenced until the precautionary measures have been inspected and approved by the relevant Building Surveyor.

The Demolisher shall construct a temporary crossing placed over the footpath, as required by the

No part of any external wall on or within 3.00m of a street alignment may be pulled down, except during the hours that the Relevent Building Surveyor directs.

Protective outriggers, fences, awnings, hoarding, barricades and the like must be installed where necessary to guard against danger to life or property or when required by the Relevant Building

Dust creating material, unless thoroughly dampened down, shall not be thrown or dropped from the building but shall be lowered by hoisting apparatus or removed by material chutes. All chutes shall be completely enclosed and a danger sign shall be at the discharge end of every chute.

All practicable precautions shall be taken to avoid danger from collapse of a building when any part of a framed or partly framed building is removed.

Demolished material shall not be allowed to remain on any floor or structure if the weight of the material exceeds the safe carrying capacity of the floor or structure, and such material shall not be so piled or stacked that it will endanger workmen or other persons, and shall be removed as soon

No wall, chimney or other structure or part of a structure shall be left unattended or unsupported in such a condition that it may collapse due to wind or vibration or other-wise become dangerous.

Before demolition is commenced, and also during the progress of such works, all electrical cable or apparatus which are liable to be a source of danger - other than cable or apparatus used for the demolition works- shall be disconnected.

Arrangements shall be made with the Relevant Electrical Supply Authority for the disconnection of elctrical mains supply except that, where partial demolition is proposed, the licensed Electrical Contractor shall satisfy the Relevant Electrical Supply Authority that the portion of the building to

The Demolisher shall be responsible for the disconnection of all telecommunication supplies.

The Demolisher shall be responsible to cut and seal any storm water, sewer pipes, water

The position of capped sewer and storm water drains sealed-off water supply lines, gas supply lines and the like are to be clearly marked on the site

Any septic tank(s) on the demolition site shall be emptied and filled with clean sand, or removed entirely, and any soak wells, leach drains or similar apparatus shall be removed of filled with clean

Any swiming pools, ponds or the like either on the demolition site or on the neighbouring allotments where affected by the demolition work shall be adequately fenced and made safe so as to comply with 'AS 1926 Swiming Pool Safety' Parts 1 & 2 prior to commencement of any

Materials removed or displaced from the building shall not be placed in any street, road or right of way and, before commencing, where required, shall be kept sprayed with water so as to prevent any nuisance from dust.


Materials removed or displaced from the building being demolished or materials left standing shall not be burned on the demolition site.

Removal of buildings by road must be approved by relevant Council Traffic Engineer.

A site managment plan is to be implemented during demolition works ro control sediment run-off in accordance with EPA Victoria publication #275: Construction Techniques for sediment Pollution Control. Provide 'propex' or equivalent silt fences to the low side of the allotment and around all soil stockpiles and storm water inlet pits/sumps and install 'silt stop' filter bags over all storm water entry pits during demolition works. 'Supergro' or equivalent erosion control fabric to be placed over garden beds to prevent surface erosion during revegitation period.

It is the builders responsibility to carry out an audit prior to the commencement of any works to determine if asbestos is present in the existing works. Where any asbestos product is found in the proposed works area during initial inspection or during the course of the demolition works the builder shall engage an authorised and registered contractor for safe removal and lawful disposal.

A building Permit is required prior to the commencement of these works. The release of these documents is conditional to the owner obtaining the required Building

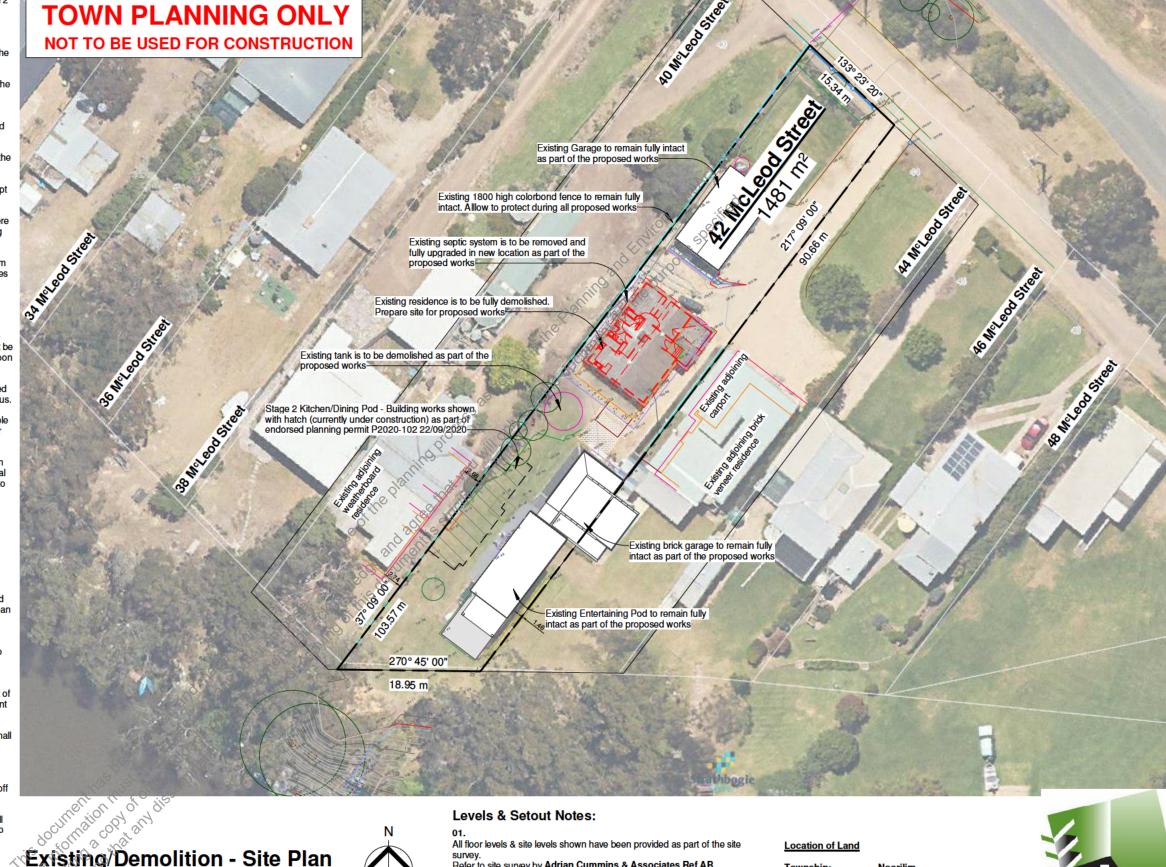

Existing/Demolition - Site Plan



All floor levels & site levels shown have been provided as part of the site survey.

Refer to site survey by Adrian Cummins & Associates Ref AB Final levels & setout to be confirmed onsite between client & contractor

Site levels shown are predevelopment levels Final onsite levels to be confirmed by builder. Location of Land

Township Section: Crown Allotment: Title Reference:

Date: 30/09/2021 1:25:05 PM

26D & Part 7 Vol 4031 Fol 188 8690 313

building designers

Existing/Demolition Plans

Scale @ A3 - As indicated

Town Planning Issue

Revision No. Revision Description Revision Date Elberton Farming PTY LTD Trading as **CBA Building Designers** RBP No. CDP-AD57101



Client:

Drawn:HM

42 McLeod St, Kirwans Bridge 3608

Project:

21-00

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Sheet No.

TP01

Site Legend

Under Construction

Existing Structures

Proposed



Proposed Areas		
Name	Area	Squares
Storage & Bedrooms	99.45 m ²	10.70
Master Suite & Laundry	81.84 m ²	8.81
Swimming Pool Area	72.10 m ²	7.76
WT	9.51 m ²	1.02
Grand total: 4	262.90 m ²	28.30

Existing Areas			
Name	Area	Squares	
Front Shed	84.94 m ²	9.14	
Brick Garage/Storage	26.60 m ²	2.86	
Kitchen Pod	66.05 m ²	7.11	
Living Area Pod	72.93 m ²	7.85	
Grand total: 4	250.53 m ²	26.97	

Existing Roofed Areas		
Area	Squares	
47.77 m ²	5.14	
32.32 m ²	3.48	
80.09 m ²	8.62	
	Area 47.77 m² 32.32 m²	

Levels & Setout Notes:

All floor levels & site levels shown have been provided as part of the site survey. Refer to site survey by <u>Adrian Cummins & Associates Ref AB</u>

9163-20-01
Final levels & setout to be confirmed onsite between client & contractor.

Site levels shown are predevelopment levels. Final onsite levels to be confirmed by builder.

Location of Land

Township:

Crown Allotment: 26D & Part 7 Vol 4031 Fol 188


These drawings are to be read in conjunction with computations & documents prepared by others.

Refer to survey: AB 9163-20-01 By: Adrian Cummins & Associates

LCA Report: 26626 By: Colin Nankervis Consulting Engineers Date: 15/10/2020

Septic Design Contact: By: Sepserve Wastewater

42 McLeod Street				
Areas Site: Existing Buildings: Proposed Buildings: Total:	1481.290m ² 330.620m ² 262.900m ² 593.520m ²	100.00% 22.319% 17.748% 40.067%		

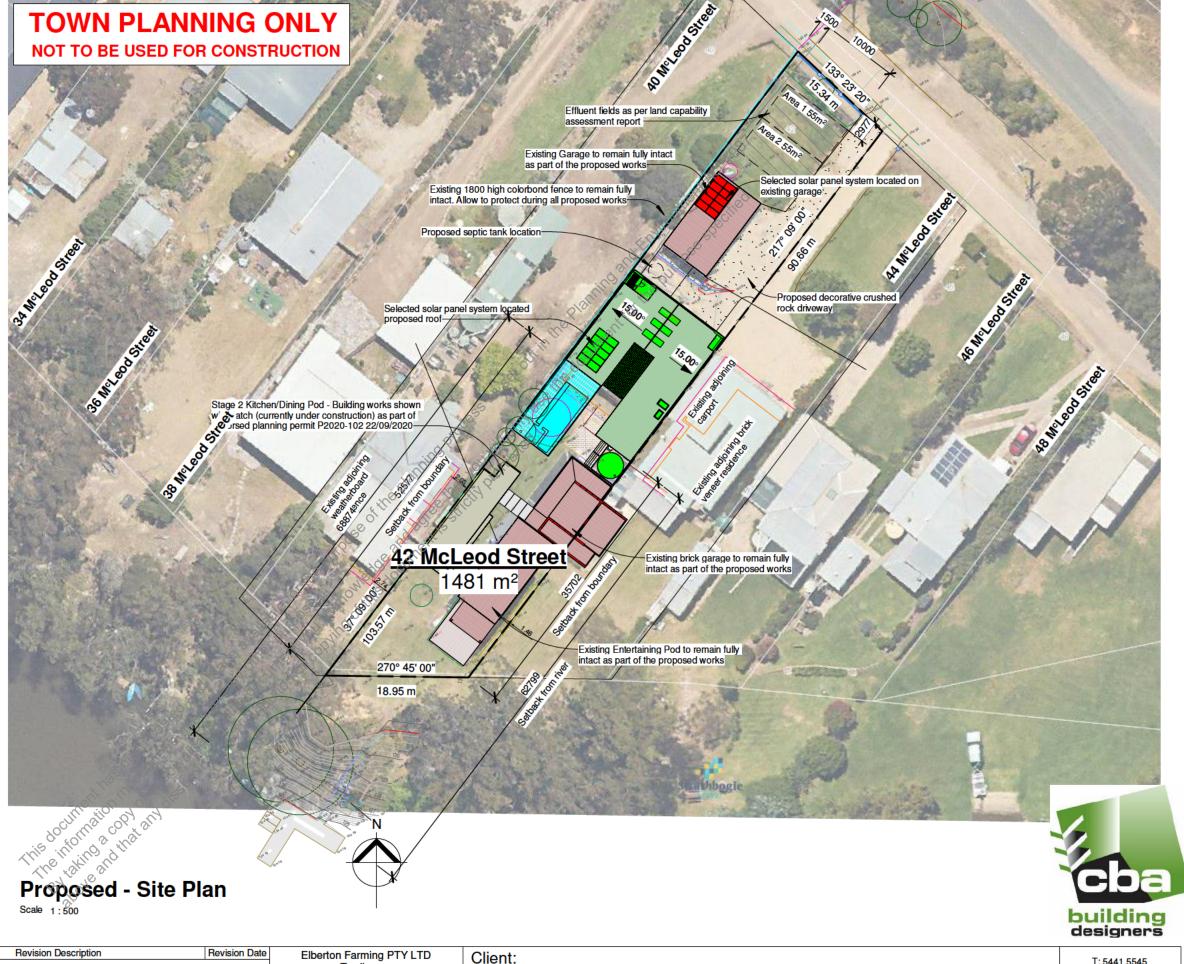

Proposed Site Plan

Scale @ A3 - As indicated

Town Planning Issue

Revision No. Revision Description

Elberton Farming PTY LTD Trading as CBA Building Designers RBP No. CDP-AD57101



Drawn:HM


42 McLeod St, Kirwans Bridge 3608

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Project: 21-00

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Sheet No. **TP03**



FFL Areas

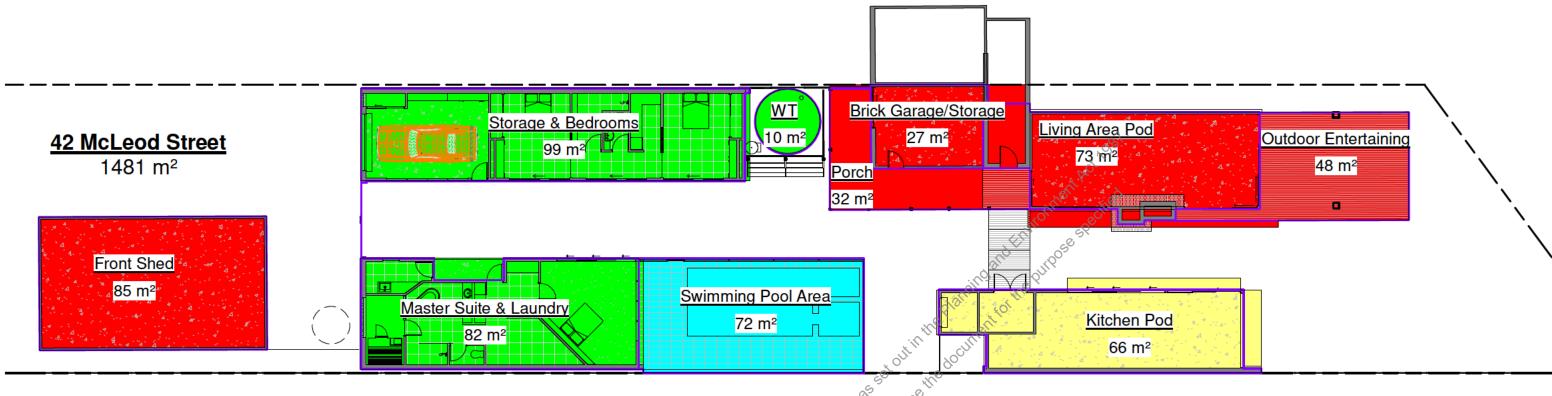Scale 1:200

Site Legend

Under Construction Existing Structures Proposed Pool Area (By Others)

Propos	Proposed Areas		
Name	Area	Squares	
Storage & Bedrooms	99.45 m ²	10.70	
Master Suite & Laundry	81.84 m ²	8.81	
Swimming Pool Area	72.10 m ²	7.76	
WT	9.51 m ²	1.02	
Grand total: 4	262.90 m ²	28.30	

Existi	ng Areas		Exis
Name	Area	Squares	Name
Front Shed	84.94 m ²	9.14	Outdoor Enter
Brick Garage/Storage	26.60 m ²	2.86	Porch :
Kitchen Pod	66.05 m ²	7.11	Grand total: 2
Living Area Pod	72.93 m ²	7.85	20 No. C
Grand total: 4	250.53 m ²	26.97	66, 47 W
	< rid	document he information	Porch & Grand total 2

as			Existing Roofed Areas		
a	Squares		Name	Area C	Squares
1 ²	9.14		Outdoor Entertaining	47.77 m²	5.14
1 ²	2.86		Porch Co	32,32 m ²	3.48
1 ²	7.11	1 I	Grand total: 2	80.09 m ²	8.62
1 ²	7.85		30 100 100 inly		
m²	26.97	, e	of allegille		
This	By above a good of the state of	ind ing	Name Outdoor Entertaining Porch Grand total: 2		

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Areas Scale @ A3 - As indicated Town Planning Issue

Revision No. Revision Description Revision Date

Elberton Farming PTY LTD Trading as

CBA Building Designers RBP No. CDP-AD57101



Client:

42 McLeod St, Kirwans Bridge 3608

Date:30/09/2021 1:25:34 PM

Project:

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Sheet No.

21-00 **TP10**



1 October 2021

Principal Planner Strathbogie Shire Planning Department PO Box 177, Euroa Vic 3666

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Application P2021-178 42 McLeod Street Kirwans Bridge, Development of a Replacement Dwelling 2. Clarification of total site coverage

Total site area of the coverage

Total site area of the coverage

Total site area of the coverage of Re

Existing Building Stock
Eropt Shed

Brick Gar Existing But Evictorial Report Shed Brick Entertaining Pod

Entertaining Pod

Brick Garage/Storage

Kitchen Pod (under Propose-Total 251 sqm

82 sqm Bedroom/Garage Pod 99 sqm Total 181 sqm **Existing Stock** 251 sqm **Proposed Stock** 181 sqm Total 432 sqm

Land size

1481 sqm

Total building site coverage

29.2%

Total structure site coverage

40.02%

Refer to CBA Building Designers Planning DocumentationTP10 (attached)

3. Environmental Health

outlines the treatment system recommended which will be installed as a wick trench disposal system with works undertaken by Peter Fowler from SepServed Waste Water (Strathfieldsaye).

have successfully installed this system recently within the area at 32 McLeod Street, Kirwans Bridge (December 2020) permit attached for your information.

4. Drainage and Crossover.

Drainage and Crossover.

It is proposed all excess drainage from the water storage tanks will be connected to the legal point of discharge, working with the natural ground levels on site this should be to the front of the property. Note there is no existing crossover to the site.

5. Section 52 to Goulburn Murray Water given the proximity to the Goulburn River (within 100m) and the concerns about the capability of the site to manage wastewater and proposed site coverage.

The proposed works are set back from the rear boundary approximately 35.7 and 52.5 metres, and 62 Pand 68 8 metres for the river bank.

The proposed works are also set behind the existing building stock that will remain on site.

n veference to management of wastewater please refer to the response to item

The proposal will be advertised to adjacent property owners and occupiers given the proximity to existing dwellings being within 100m and this again moves it out of being able to be considered as a VicSmart.

We understand the requirement to advertise to the adjoining neighbours, who have all been continually informed during this design process.